# JOHNSTON COUNTY DEPARTMENT OF UTILITIES DUCHESS DOWNS FORCE MAIN IMPROVMENTS OCTOBER 2017


**Owner: Johnston County** 

### **BOARD OF COMMISSIONERS**

Jeffrey P. Carver - Chairman Ted G. Godwin - Vice Chairman Cookie Pope Allen L. Mims, Jr. Chad M. Stewart Keith Branch Larry Wood

County Manager Rick J. Hester



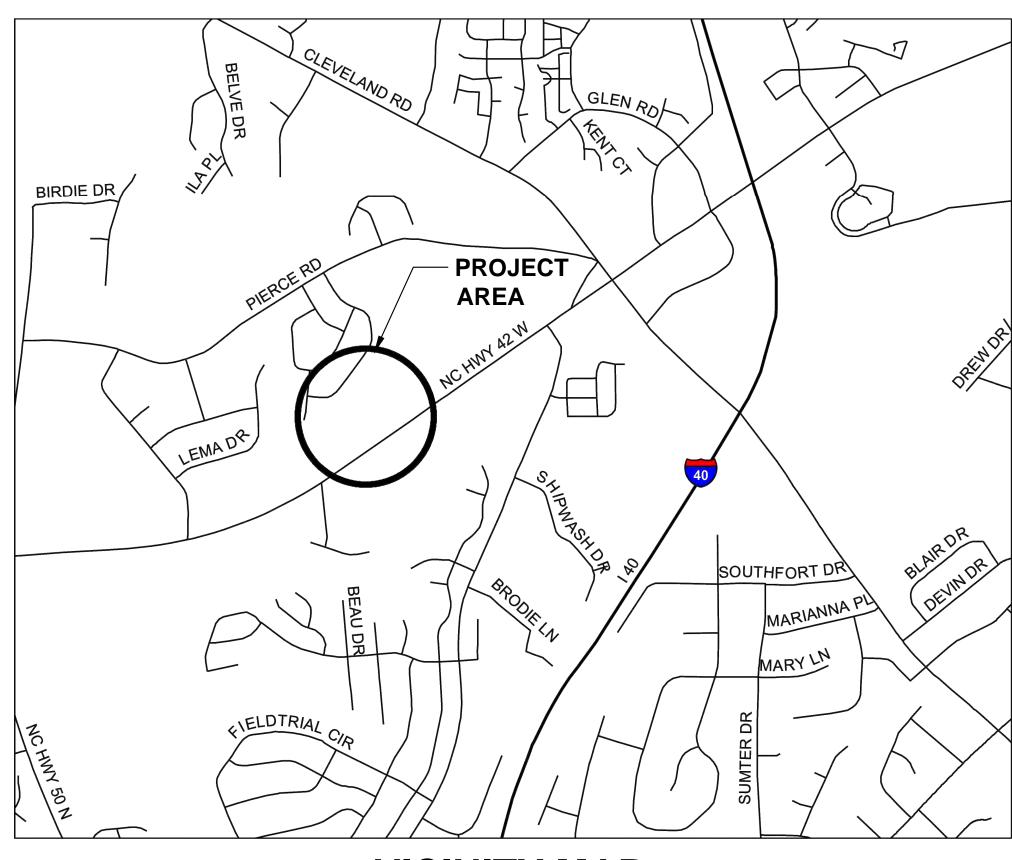


VICINITY MAP
NOT TO SCALE

### **PLAN INDEX**

- 1 COVER SHEET
- C1 PLAN AND PROFILE
- C2 PLAN AND PROFILE
- D1 DETAIL SHEET
- D2 PUMP STATION AND DETAIL SHEET



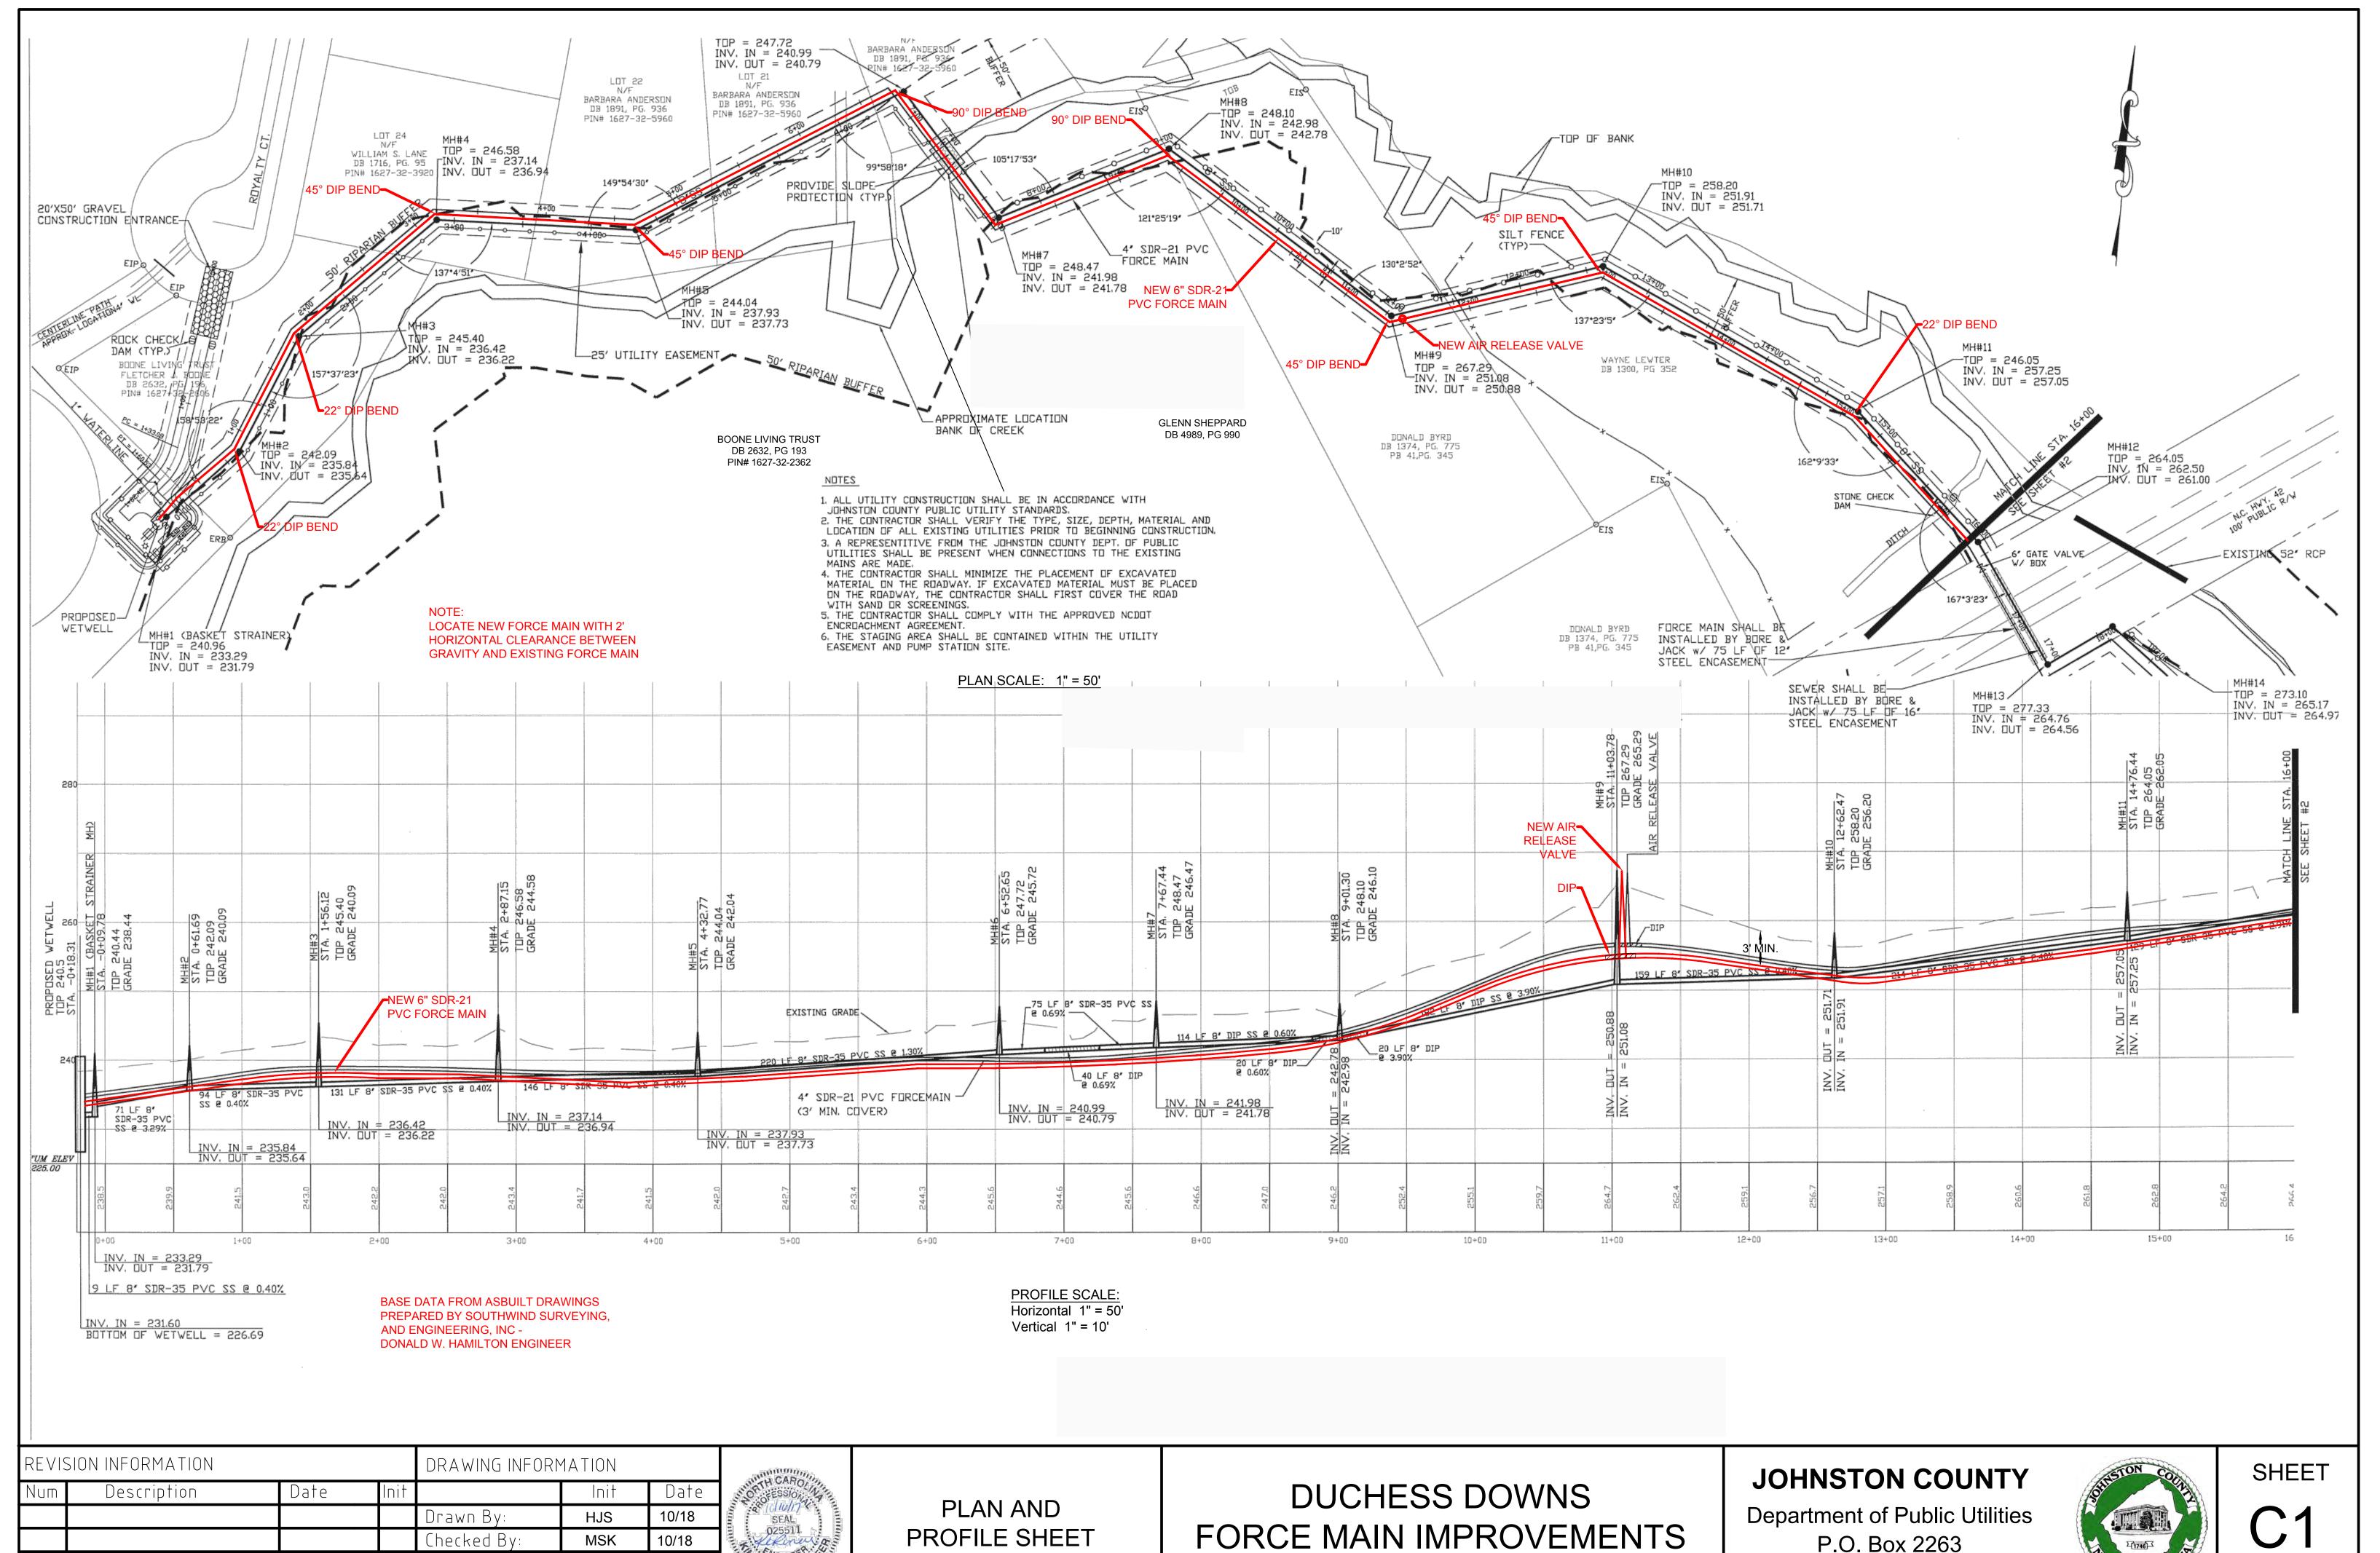


SCALE: AS SHOWN



P.O. Box 2263 Smithfield, NC 27577



of

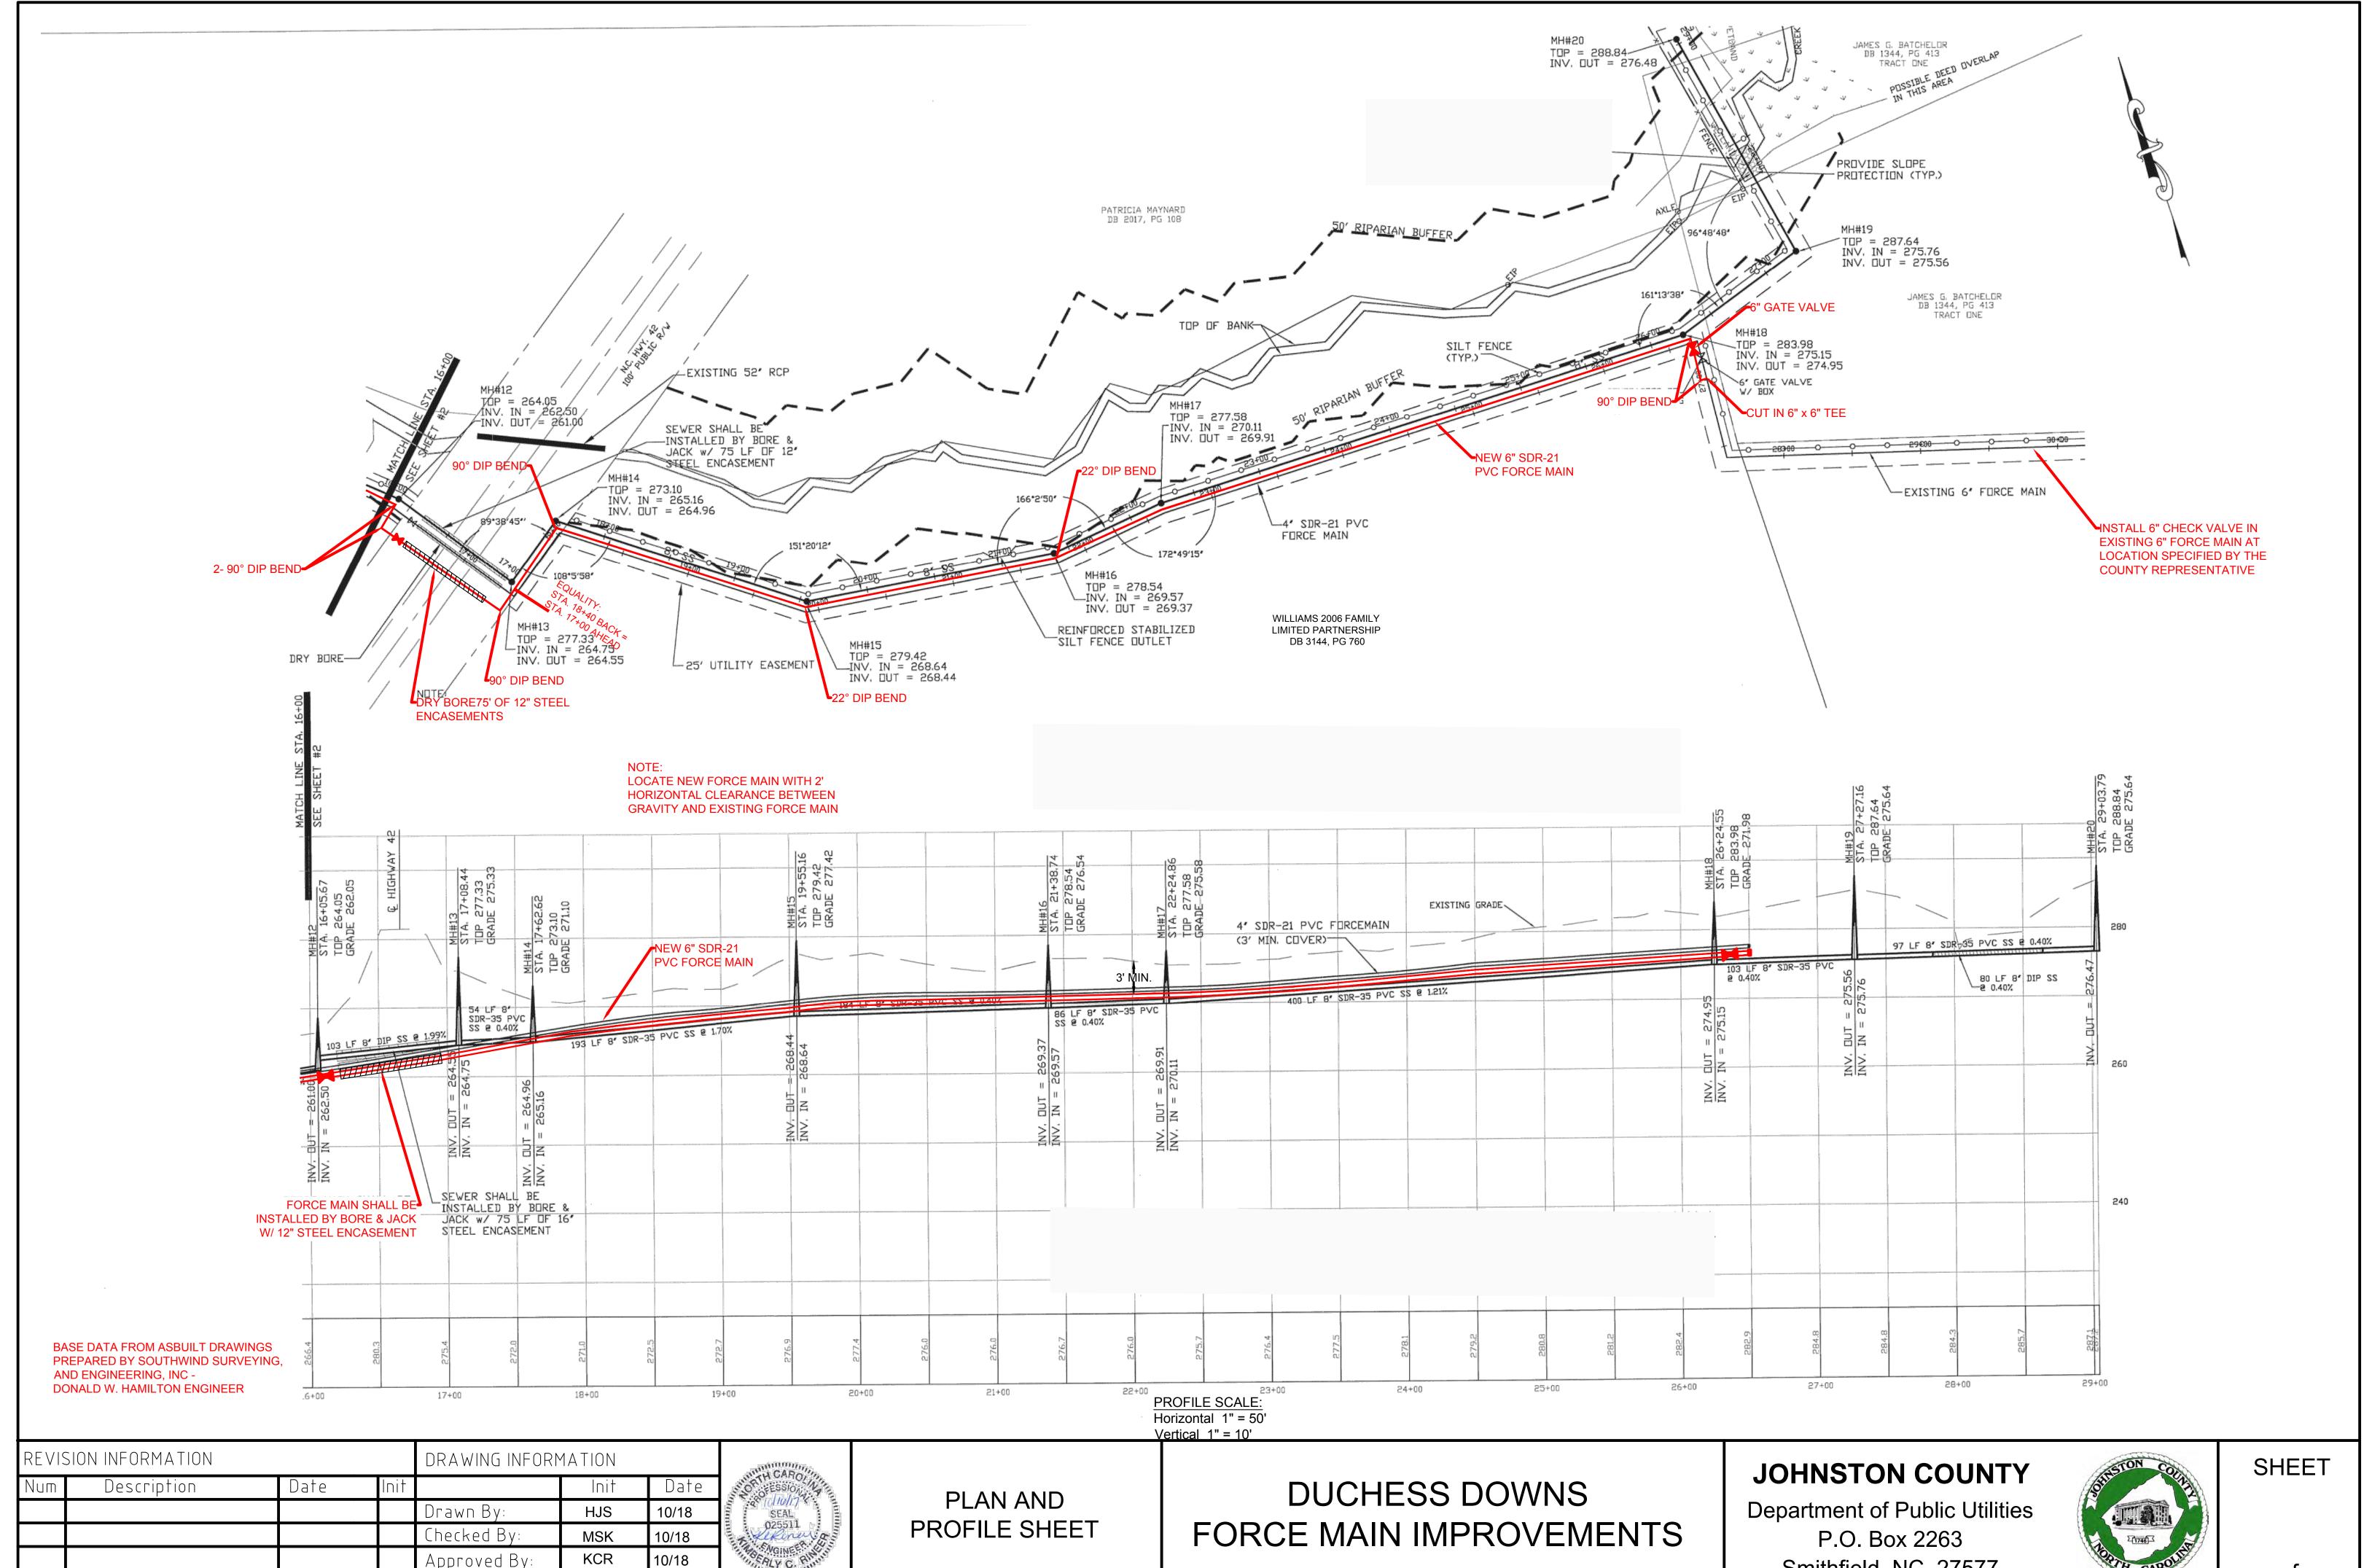



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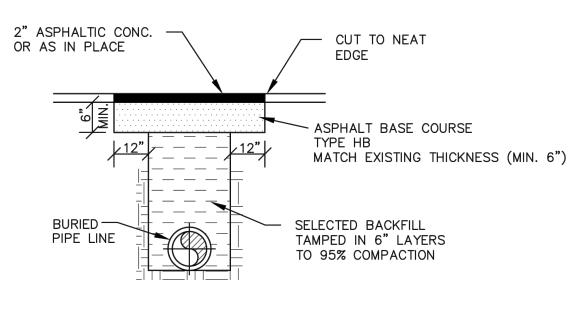
Smithfield, NC 27577



of



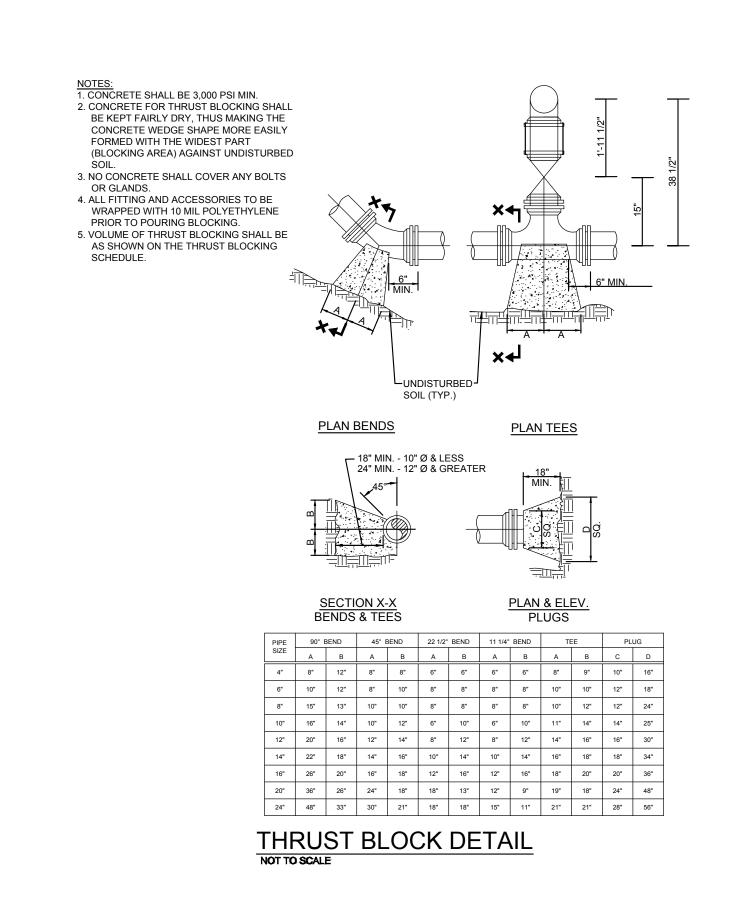

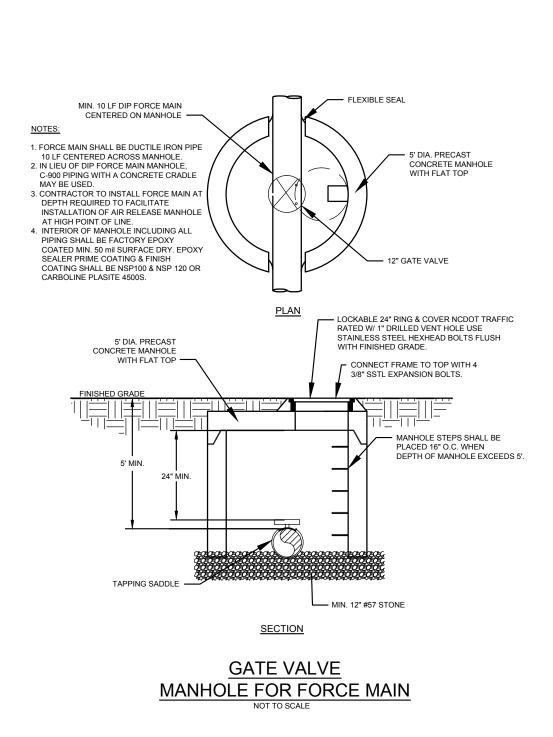


### SECONDARY HIGHWAYS

**DETAILS FOR CUTTING** 

AND REPLACING PAVEMENT


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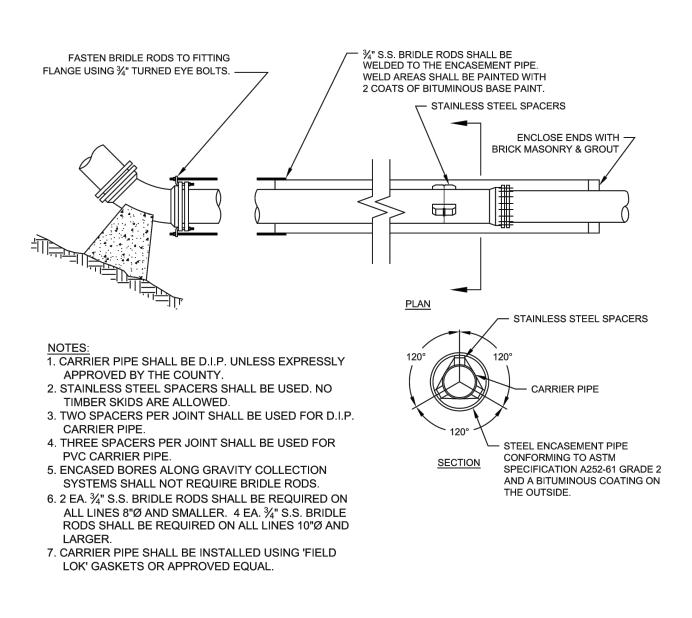


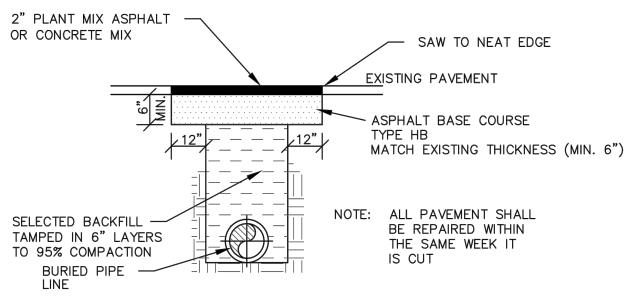
PRIMARY HIGHWAYS


THRUST COLLAR —

 $\frac{3}{4}$ " S.S. THREADED RODS —



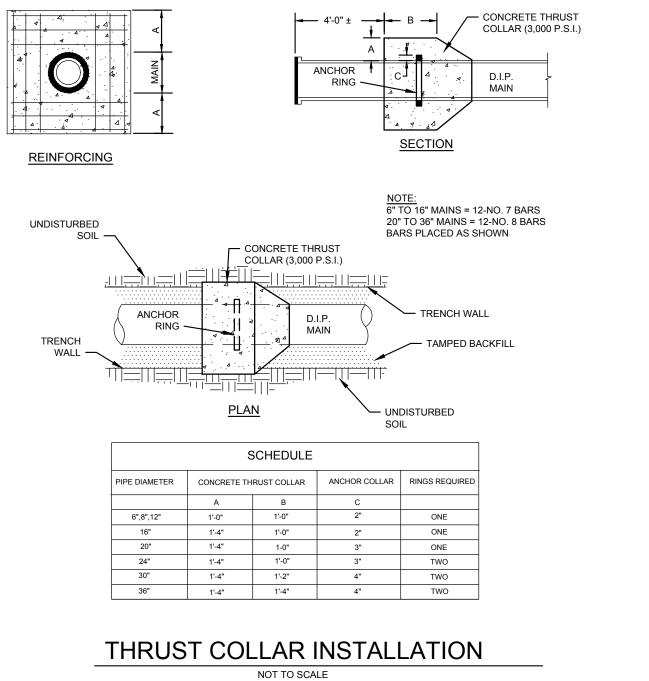

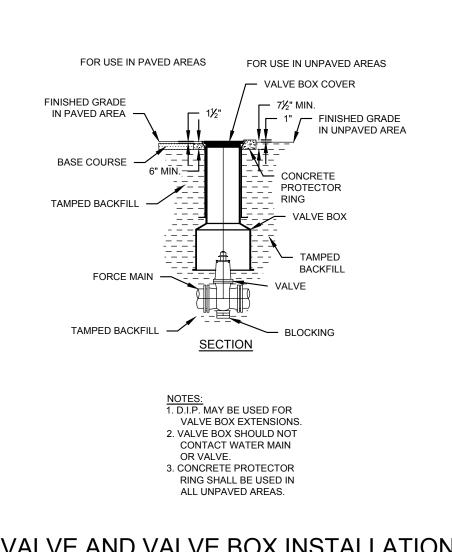

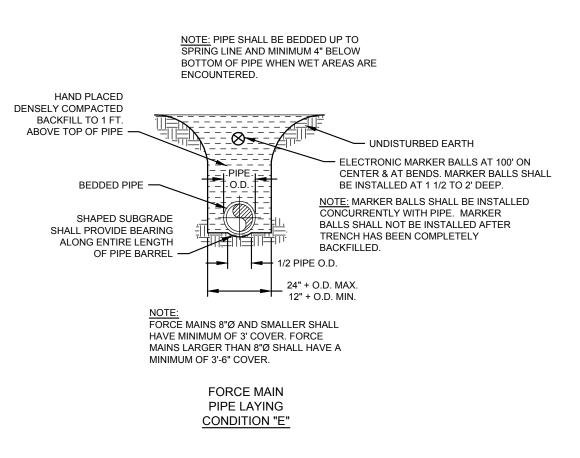


STANDARD BORE ENCASEMENT
NOT TO SCALE

VALVE AND VALVE BOX INSTALLATION

PIPE LAYING CONDITION
NOT TO SCALE

REV	REVISION INFORMATION			DRAWING INFORMATION		
Num	Description	Date	Init		Init	Date
				Drawn By:	HJS	10/18
				Checked By:	MSK	10/18
				Approved By:	KCR	10/18
				SCALE: AS SHOWN		

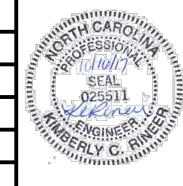

**DETAIL SHEET** 

**DUCHESS DOWNS** FORCE MAIN IMPROVEMENTS

### **JOHNSTON COUNTY**

Department of Public Utilities P.O. Box 2263 Smithfield, NC 27577



— CONCRETE THRUST BLOCK

SEE THRUST BLOCK DETAIL

FOR DIMENSIONS OF BLOCK.

ALL PIPE SEGMENTS LESS THAN

10' SHALL REQUIRE RODDING.

- CONCRETE THRUST BLOCK

SEE THRUST BLOCK DETAIL

FOR DIMENSIONS OF BLOCK.

AT 90° BEND.

ROD REQUIREMENTS

SIZE OF 45° BEND STATIC THRUST IN POUNDS NUMBER OF RODS REQUIRED

17,312

30,779

48,091

69,252

GENERAL NOTES

1. RODS AND NUTS SHALL BE OF TYPE 304 OR TYPE 316 STAINLESS STEEL.

2. CONCRETE SHALL NOT CONTACT BOLTS OR ENDS OF MECHANICAL JOINT BENDS.


VERTICAL BEND RODDING

AND BLOCKING DETAIL

NOT TO SCALE

AT 45° BEND.

PAGE

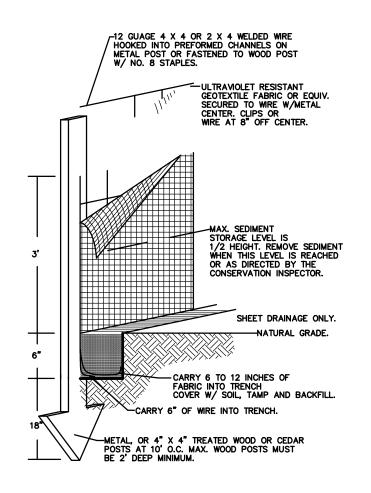

NOTE:
SILT FENCES SHOULD NOT BE USED AT PIPE OUTLETS
OR IN AREAS OF CONCENTRATED FLOWS (CREEKS,
DITCH INES SWALES ETC.)

NOTES:


(1) STONE SHOULD BE PLACED OVER THE CHANNEL BANKS TO KEEP
WATER FROM CUTTING AROUND THE DAM.

(2) STONE CHECK DAMS SHOULD BE SPACED IN A CHANNEL SO THAT THE
CREST OF THE DOWNSTREAM DAM IS AT THE SAME ELEVATION OF
THE TOE OF UPSTREAM DAM.

SECTION A - A

STONE CHECK

SILT FENCE DETAIL
NOT TO SCALE

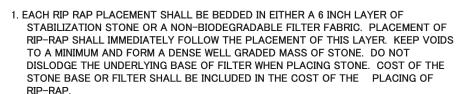

- 2. THE DIAMETER OF THE LARGEST STONE SHALL NOT EXCEED 1.5 TIMES THE SIZE OF THE RIP-RAP. MAXIMUM STONE SIZE WHEN USING 8 INCH D50 WILL BE 12 INCHES AND THE MINIMUM THICKNESS OF THE RIP-RAP LAYER SHALL BE 18 INCHES.
- 3. MAXIMUM SLOPE OF THE CHANNEL BANK SHALL NOT EXCEED 2.0 HORIZONTAL TO 1.0 VERTICAL. FINISHED GRADE OF THE RIP-RAP IS TO BLEND WITH THE SURROUNDING AREA.
- 4. INSPECT RIP-RAP PERIODICALLY FOR SCOUR OR DISLODGED STONES (ESPECIALLY AFTER SEVERE STORMS) AND WEED BRUSH GROWTH.

RIP RAP PLACEMENT DETAIL

6" GRAVEL FILTER OR

FILTER CLOTH

NO CASE LESS THAN 6"

MINIMUM THICKNESS (T) SHOULD BE 1.5 TIMES THE MAXIMUM STONE DIAMETER, BUT IN

### JOHNSTON COUNTY SEEDING SPECIFICATIONS (Updated 05/19/14)

TEMPORARY SEEDING SCHEDULE					
Date	Туре	Planting Rate (lbs/acre)			
Cont 1 Amril 20	Tall Fescue and	150			
Sept 1 – April 30	Abruzzi Rye	150			
	Tall Fescue and	150			
May 1 – Aug 31	Browntop or German Millet <i>or</i>	40			
	Sorghum-Sudan Hybrids	40			

SHOULDERS, SIDE DITCHES, SLOPES (For Slopes between 2:1 and 3:1)					
Date	Туре	Planting Rate (lbs/acre)			
Mar 1 – June 1	Sericea Lespedeza (scarified)	50			
Mai 1 – Julie 1	and				
Mar 1 – Apr 15	Add Tall Fescue	120			
Mai 1 – Api 13	or				
Mar 1 – June 30	Add Weeping Lovegrass	10			
Iviai 1 – Julie 30	or				
Mar 1 – June 30	Add Hulled Common Bermuda grass	25			
	***Tall Fescue <i>and</i>	120			
June 1 – Sept 1	***Browntop or German Millet <i>or</i>	35			
	***Sorghum-Sudan Hybrids	30			
Cont 1 Mor 1	Sericea Lespedeza (unhulled/unscarified) and	70			
Sept 1 – Mar 1	Tall Fescue	120			
Nov 1 – Mar 1	Add Abruzzi Rye	25			

SHOULDERS, SIDE DITCHES, SLOPES (For Slopes between 3:1 and Flatter)					
Date	Туре	Planting Rate (lbs/acre)			
Aug 15 – Nov 1	Tall Fescue	300			
Nov 1 – Mar 1	Tall Fescue and Abruzzi Rye	300			
Mar 1 – Apr 15	Tall Fescue	300			
Apr 15 – June 30	Hulled Common Bermuda grass	25			
	Tall Fescue and	120			
July 15 – Aug 15	***Browntop or German Millet <i>or</i>	35			
	***Sorghum-Sudan Hybrids	30			

### Notes:

Consult Johnston County Environmental and Stormwater Manager, the Johnston County Soil and Water Conservation Service, or the Cooperative Extension Service for additional information concerning other alternatives for vegetation of denuded areas. The above vegetation rates are those which do well under local conditions; other seeding rate combinations may be possible, but must be approved by the Environmental and Stormwater Manager.


\*\*\*Temporary – Reseed according to optimum season for desired permanent vegetation. Do not allow temporary cover to grow over 12 inches in height before mowing to keep fescue from being shaded out.

Fertilize – Apply lime and fertilizer according to soil tests, or apply 2,000 lb/acre ground agriculture limestone and 750 lb/acre 10-10-10 fertilizer.

Mulch – Apply 4,000 lb/acre grain straw or equivalent cover of another suitable mulch. Anchor straw by tacking with asphalt. Apply asphalt at 0.10 gallons per square yard (10 Gal / 10,000 SF).

Maintenance – If growth is less than fully adequate, re-fertilize in the second year, according to soil tests or topdress with 500 lb/acre 10-10-10 fertilizer. Reseed, fertilize, and mulch damaged areas immediately.

### COIR FIBER WATTLE DETAIL

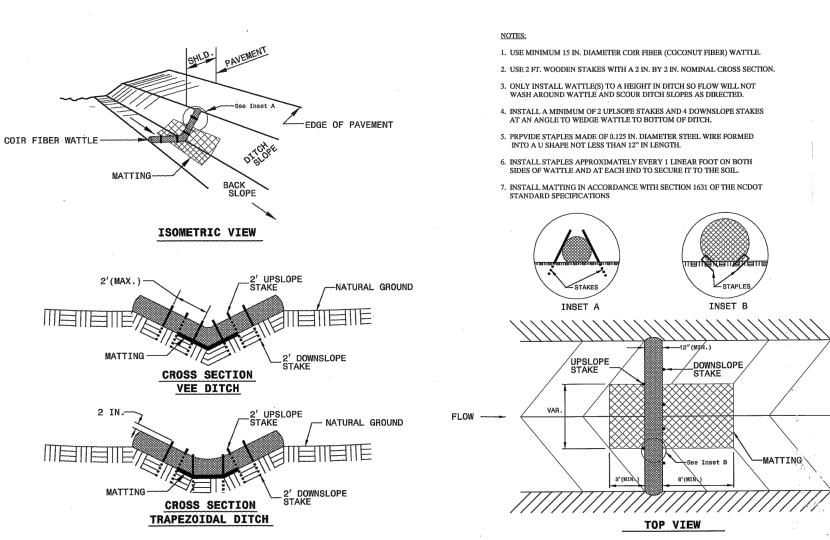

### Construction Sequence

- Obtain all necessary permits.
   Call Thad Valentine, NCDENR Land Quality at (919) 791-4200 for on-site inspection by Inspector.
   Install gravel construction entrance, temporary diversions, silt fencing, sediment basins or other measures as shown on the approved plan. Clear only as necessary to install these devices.
- Begin clearing and grubbing. Maintain devices as needed. Rough grade site. All disturbed ditches shall be stabilized immediately with matting.
   Install storm sewer (if shown) and protect inlets with silt fencing,

sediment traps or other approved measures as shown on the plan.

- Begin construction on pipelines.
   Stabilize site as areas are brought up to finish grade with vegetation, paving, ditch linings, etc. Install stabilization, temporary or permanent, at maximum intervals of every 5,000 LF or 15 working days, whichever
- 8. Trenches shall be backfilled and check dams shall be installed in ditches adjacent to work area daily.9. All areas shall have positive drainage following final grading.

10. When construction is complete and all areas are stabilized

- completely, call for inspection by Inspector.

  11. If site is approved, remove construction entrance, temporary diversions, silt fencings, sediment basins, etc. and seed out or pave any resulting bare areas. All remaining permanent erosion control devices (such as elocity dissipaters) should be installed now.

  12. When vegetation has become established, call NCDENR at (919)
- NOTE: All sediment and erosion control devices shall be checked and maintained weekly or after any runoff producing rainfall event.

791-4200 for final site inspection by Inspector.

### SEEDBED PREPARATION

- 1. CHISEL COMPACTED AREAS AND SPREAD TOPSOIL 3 INCHES DEEP OVER ADVERSE SOIL
- CONDITIONS, IF AVAILABLE.
  2. RIP THE ENTIRE AREA TO 6 INCHES DEPTH.
- REMOVE ALL LOOSE ROCK, ROOTS, AND OTHER OBSTRUCTIONS LEAVING SURFACE REASONABLY SMOOTH AND UNIFORM.
   APPLY AGRICULTURAL LIME, FERTILIZER, AND SUPERPHOSPHATE UNIFORMLY AND MIX WITH SOIL
- (SEE BELOW\*).

  5. CONTINUE TILLAGE UNTIL A WELL − PULVERIZED, FIRM, REASONABLY UNIFORM SEEDBED IS PREPARED 4 TO 6 INCHES DEEP.
- SEED ON A FRESHLY PREPARED SEEDBED AND COVER SEED LIGHTLY WITH SEEDING EQUIPMENT OR CULTIPACK AFTER SEEDING.
- 7. MULCH IMMEDIATELY AFTER SEEDING AND ANCHOR MULCH.
- 8. INSPECT ALL SEEDED AREAS AND MAKE NECESSARY REPAIRS OR RESEEDINGS WITHIN THE PLANTING SEASON, IF POSSIBLE. IF STAND SHOULD BE OVER 60% DAMAGED REESTABLISHED
- CONSULT CONSERVATION INSPECTOR ON MAINTENANCE TREATMENT AND FERTILIZATION AFTER PERMANENT COVER IS ESTABLISHED.
- \* APPLY:

  AGRICULTURAL LIMESTONE 2 TONS/ACRE OR 3 TONS/ACRE IN CLAY SOILS

  FERTILIZER 1000 LBS/ACRE (10-10-10)

  SUPERPHOSPHATE 500 LBS/ACRE (20%)

  MULCH 2 TONS/ACRE (SMALL GRAIN STRAW)

ANCHOR - ASPHALT EMULSION AT 450 GAL./ACRE

FOLLOWING ORIGINAL LIME, FERTILIZER AND SEEDING RATES.

## S.S. JUNCTION BOX FOR PUMP POWER CABLES & CABLE HOLDER (S.S.) PLUG VALVES LIQUID LEVEL CABLES & CHAIN HOOK (S.S.) CHAIN HOOK (S.S.) PLUG VALVES CONCRETE THRUST COLLAR FLUSHING CONNECTION 90° BEND W/ BLOCKING 4" WYE 4" 45° DIP BEND 4" X 6" INCREASER GRAVITY SANITARY SEWER EXISTING PVC EXISTING PVC EXISTING PVC

PUMP STATION SITE PLAN

\_CONTROL PANEL WITH

RAINHOOD (SEE SHEET 20)

GRAVITY LIN

WITH BASKE STRAINER

- GENERATOR

RAINHOOD/PUMP

CONTROL PANEL

— AREA\LIGHT

PUMP STATION ACCESS ROAD

12' DOUBLE GATE

1" WATERLINE-

6' CHAINLINK FENCE WITH-3 STRAND BARBED WIRE

THERN MODEL 5124 HOIST W/ MODEL 524 BASE \_\_\_\_\_ SHALL BE PROVIDED FOR BASKET STRAINER

YARD HYDRANT-


6' DIA. WETWELL:

#57 STONE

(WHOLE SITE)

HERBICIDE FABRIC,

TOP 240.5

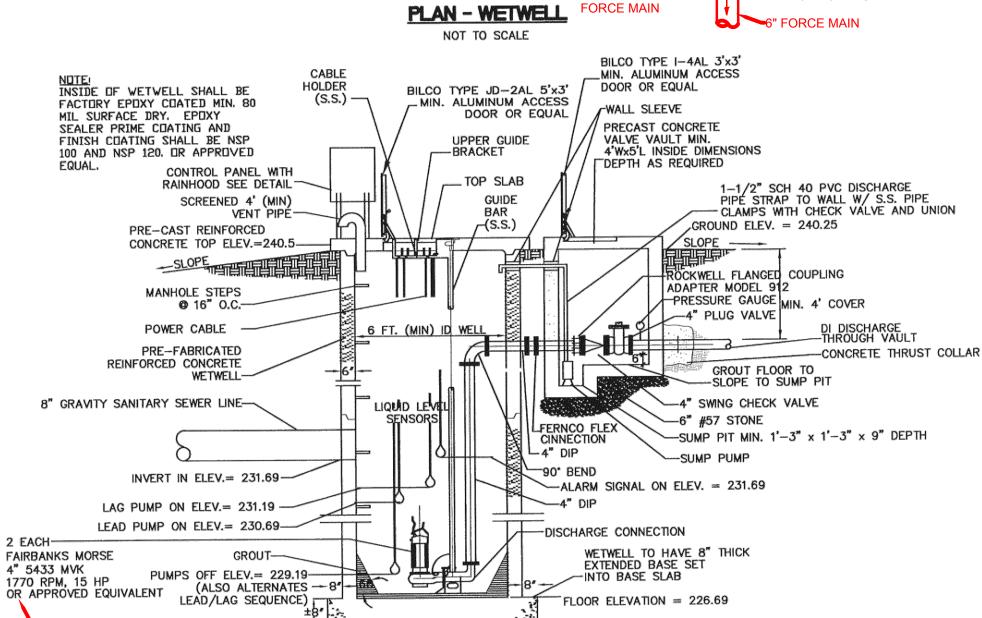

### REVISION INFORMATION Num Description Date Init Date Drawn By: HJS 10/18 Checked By: MSK 10/18 Approved By: KCR 10/18 SCALE: AS SHOWN



PUMP STATION AND DETAIL SHEET

DUCHESS DOWNS FORCE MAIN IMPROVEMENTS

### **JOHNSTON COUNTY**

TO BE REPLACED BY COUNTY WITH

FAIRBANKS MORSE 4" 5432 MUK 1770

RPM, 14 HP

Department of Public Utilities P.O. Box 2263 Smithfield, NC 27577

TYPICAL SECTION - WETWELL

NOT TO SCALE



SHEET D2